

Department of Purchasing

Mark A. Booker Director

March 23, 2023

### ADDENDUM #1, CSP#499-23-03, Hudson Middle School-Sanitary Sewer Replacement-Phase 2

This addendum forms a part of the solicitation documents, modifies the original document as indicated in the Addendum 01 provided below and is hereby made part of any pursuant award. Acknowledge receipt of this Addendum in Section 00 41 00, Paragraph 2.2 Addenda, in the bid package submittal documents. Failure to submit the acknowledgement of addenda will be used as an evaluated factor.

\*AS A REMINDER, THE SUBMITTAL DATE FOR THIS CSP REMAINS <u>11:00 AM, March 30, 2023</u> at the Garland ISD Purchasing Construction Bond Department, Marvin Padgett Auxiliary Services Center Building, 701 N. First Street, Garland, Texas 75040.

### 1. ADDITIONAL INFORMATION:

- a. Attachment 1: Pre-proposal meeting agenda and sign in record, 4 pages.
- b. Attachment 2: Garland ISD Academic Calendar 2023-2024, 1 page.

### 2. CHANGES:

- a. Bid opening is changed from March 30, 2023, 11:40 AM to 11:10 AM.
- b. Attachment 3a: Delete and Replace plan sheets with P2.00, P2.01, P2.02, and P3.03, 4 pages.

The full document under Addendum 1 is attached and available on the Google drive at: <a href="https://drive.google.com/drive/folders/1BT0cpwNixZ0Qa4525ZILrx3a4ze0xn6n">https://drive.google.com/drive/folders/1BT0cpwNixZ0Qa4525ZILrx3a4ze0xn6n</a>

Mark A. Booker

**Executive Director of Purchasing** 

Mark a. Booke



# FACILITIES AND MAINTENANCE PRE-PROPOSAL CONFERENCE AGENDA

**Project: CSP 499-23-03** 

Date: Tuesday, MARCH 21,2023 9:00 AM

### 1. Attendance:

Sign-in Sheet

### 2. Project Personnel:

Brian Finley Senior Maintenance Project Manager Garland Independent School District 701 N. First Street

Garland, TX 75040

Office: 972-487-4102 | Mobile: 214-500-2854

E-mail: BRFinley@garlandisd.net

RWB Consulting Engineers Nathan Hart, P.E., Engineer of Record 12001 N. Central Expwy, Suite 1100 Dallas, TX 75243

Phone: 972-788-4222| Mobile: 214-695-7613

E-mail: <a href="mailto:nhart@rwb.net">nhart@rwb.net</a> w/CC: <a href="mailto:mdanielson@rwb.net">mdanielson@rwb.net</a>

Nancy Nunez, MBA, RTSBA
Construction Bond Specialist
Purchasing, Garland Independent School District
E-mail: <a href="mailto:nrnunez@garlandisd.net">nrnunez@garlandisd.net</a>
bids@garlandisd.net

- 3. Brief Scope Review by Engineer:
- 4. Special Concerns: Timeline

### Garland ISD CSP# 499-23-03 HUDSON MS SANITARY SEWER LINE REPLACEMENT - PHASE 2

### 5. Special Conditions / Items Discussion:

- Active campus
- Project phasing to be considered as part of overall project cost

### 6. Safety:

- Contractor safety plan required
- Access
- Parking
- Storage
- Lay-down area
- Temporary offices
- Sanitary facilities
- Badges / photo identification

### 7. Risk of After-hours Ignition from Hot Work and Requirement for Fire Watch:

### 8. Completion Dates:

Substantial Completion AUGUST 6, 2024Final Completion OCTOBER 1, 2024

### 9. Project Budget:

**HUDSON MS** 

• Construction Cost Limitation (CCL) \$ 1,100,000

In Contract Owner Controlled Contingency (IC) \$ 200,000

### 10. Project Documents:

- Proposal: Available at https://garlandisd.net/connect/how-do-business-us/current-bidrfp-opportunities
- Submit Intention to Propose Form
- All questions to be submitted in writing to:
- Bids@garlandisd.net and Nancy Nunez, NRNunez@garlandisd.net

Last Day for receiving questions: CLOSE OF BUSINESS WEDNESDAY- MARCH 22, 2023

Last Day for issuing Addenda: MARCH 23, 2023

### 11. Proposal Addendums:

Response to questions via addenda

### 12. HUB Requirement:

- A request will be sent to provide the HUB effort and document in a fillable format to be returned ASAP with your schedule of values.
- Include HUB activity per Schedule 9, if none, submit with N/A.

Facilities and Maintenance Garland Independent School District



### Garland ISD CSP# 499-23-0 3 HUDSDN MS SANITARY SEWER LINE REPLACEMENT - PHASE 2

### 13. Proposal Delivery:

- Garland ISD Purchasing
- Marvin Padgett Auxiliary Services Center
- 701 N First Street, Garland, Texas, 75040
- Receipt of Proposals: MARCH 30, 2023 by 11:00 AM
- Proposal Opening and Read: MARCH 30, 2023 at 11:10 AM

### 14. Award:

• Anticipated board approval meeting MAY 23, 2023

### 15. Site Visit, IF NEEDED:

• Walk-thru discussion.

Garland Independent School District HUDSON MS SANITARY SEWER LINE REPLACEMENT-PHASE 2

PLEASE PRINT

499-23-03

			Tuesday, March 21, 2023 at 9:00 AM -PRE-BID Sign in sheet	MPRE-BID Sign in sheet	
ř	Name	Initial	Company	Email	Pho
	CHNIS BICHERSON	a	ENFELH	CHIUS. IN WORSON O ENTERHEIMLES - LOW	469-782
~	Nather Hox	ten	BUB	nhart@rub.not	1-881-43
2	Dank Bayards	Se Se	G22D	flanged GIBB wd BD. net (20) 789-	-682 (02)
4	AL S	J K	67.50	biting & garlandstoner	274-500-
	the Consulos	K	USIS)	Prome alogalandison	9272-936
, vo	Nous, Nones	Z,	QS19,	Nrnunez@agnandisp.na	872 48 11512. MEZ
<u>                                   </u>			3-21-2023 9:10 xm		
1/ ~					
	Clart Dillard		Varted Mechany K	cdillardo united meelmen	1,00m
0					

-6546 74137 5005-> 7-6188 1222 ---12 13 14

# 2022-23 Garland ISD Academic Calendar

S

T W TH F W TH W TH JULY **AUGUST** SEPTEMBER 

July 4: Independence Day

July 4-8: GISD administrative facilities closed

Aug. 1-5: Staff development

Aug. 8: First day of class First grading period begins

Sept. 5: Labor Day

Sept. 2: Staff development/

Student holiday

 OCTOBER

S

[17 

T W TH

Oct. 7: First grading period ends

Oct. 10-14: Fall Break

Oct. 17: Second grading period begins

### NOVEMBER

ĥ q 

Nov. 8: Staff development/ Student holiday

Nov. 21-25: Thanksgiving Break

### DECEMBER

ĥ 16] 

Dec. 16: Student early dismissal/ Staff development

Second grading period ends

Dec. 19-30: Winter Break

### JANUARY

JAN. 2: Winter Break

Jan. 3-4: Staff development/ Student holiday

Jan. 5: Third grading period begins

Jan. 16: Martin Luther King Jr. Day

### FEBRUARY

Feb. 20: Staff development/ Student holiday

### **MARCH**

ĥ 10] 

March 10: Third grading period ends

March 13-17: Spring Break

March 20: Fourth grading period begins

### **APRIL**

April 7: Student/Staff holiday

April 10: Staff development/ Student holiday

### MAY

1 27

May 26: Last day of class Student early dismissal/ Staff development

Fourth grading period ends May 29: Memorial Day

May 30: Staff development

### JUNE

### School hours

Full-day prekindergarten ...... 8:10 a.m.-3:30 p.m. Elementary school ...... 8:10 a.m.-3:30 p.m. Middle school ...... 8:50 a.m.-4:10 p.m. 

### Early dismissal times

Elementary school ...... 1:25 p.m. Middle school ...... 2:05 p.m.

### First semester: 82 days

[] Grading periods

Aug. 8-Oct. 7 (43 days) Oct. 17-Dec. 16 (39 days)

### Second semester: 93 days

[] Grading periods

Jan. 5 - Mar. 10 (45 days) Mar. 20-May. 26 (48 days)

### Stay informed

www.garlandisd.net

Facebook: @ChooseGarlandISD


Twitter: @gisdnews

YouTube: garlandisdnews

Updated: 6/28/22; subject to change

FLOOR PLAN - AREA A - PLUMBING




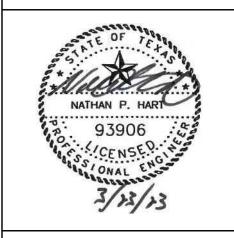

02.06.2023

ISS	SUES		
01	ISSUE FOR CONSTRUCTION	2023.02.06	
RE	VISIONS		
01	ADDENDUM NO. 1	2023.03.23	



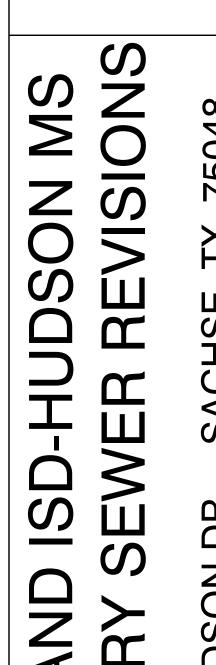


FLOOR PLAN - AREA A - PLUMBING

JOB NO.: 22112.00 DRAWN BY: MD CHECKED BY: NH


**KEY PLAN** 

P2.00

SHEET NO.

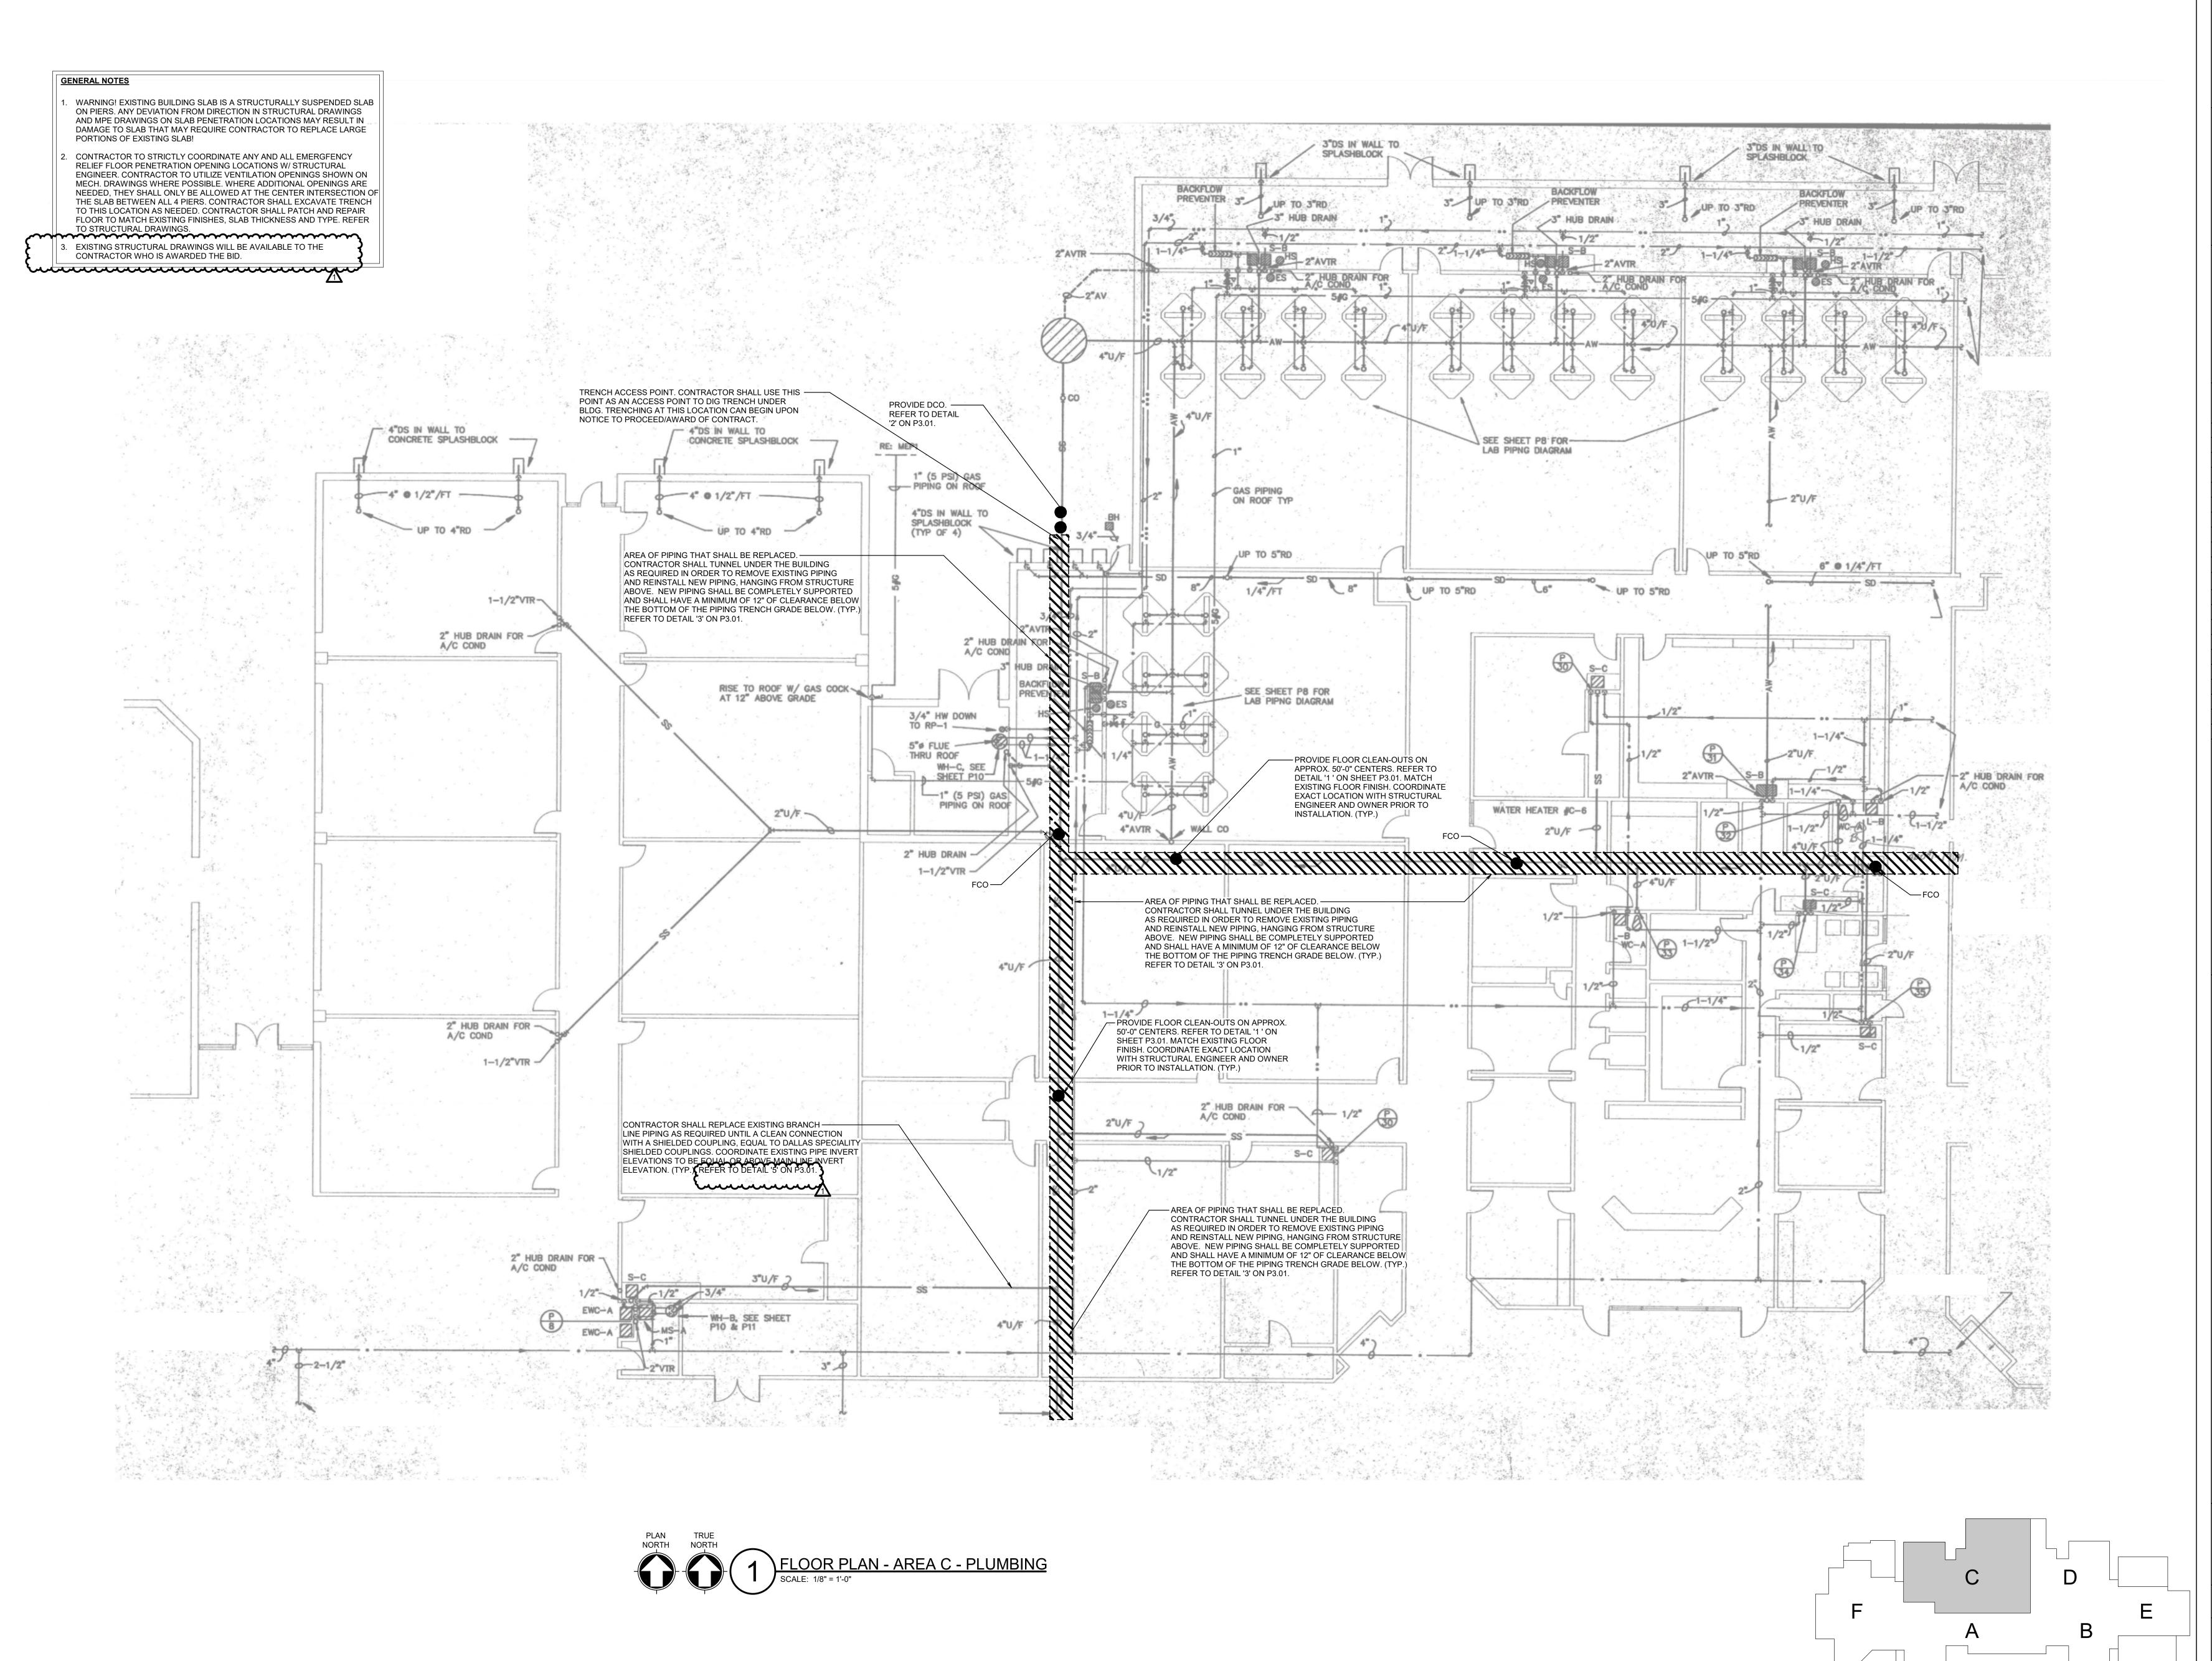



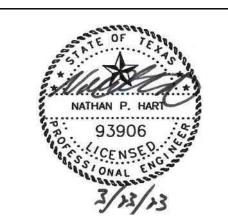

02.06.2023

ISSUES 01 ISSUE FOR CONSTRUCTION 2023.02.06 REVISIONS 01 ADDENDUM NO. 1




FLOOR PLAN - AREA C - PLUMBING


SAN


**KEY PLAN** 

JOB NO.: 22112.00 DRAWN BY: MD CHECKED BY: NH SHEET NO.

P2.01

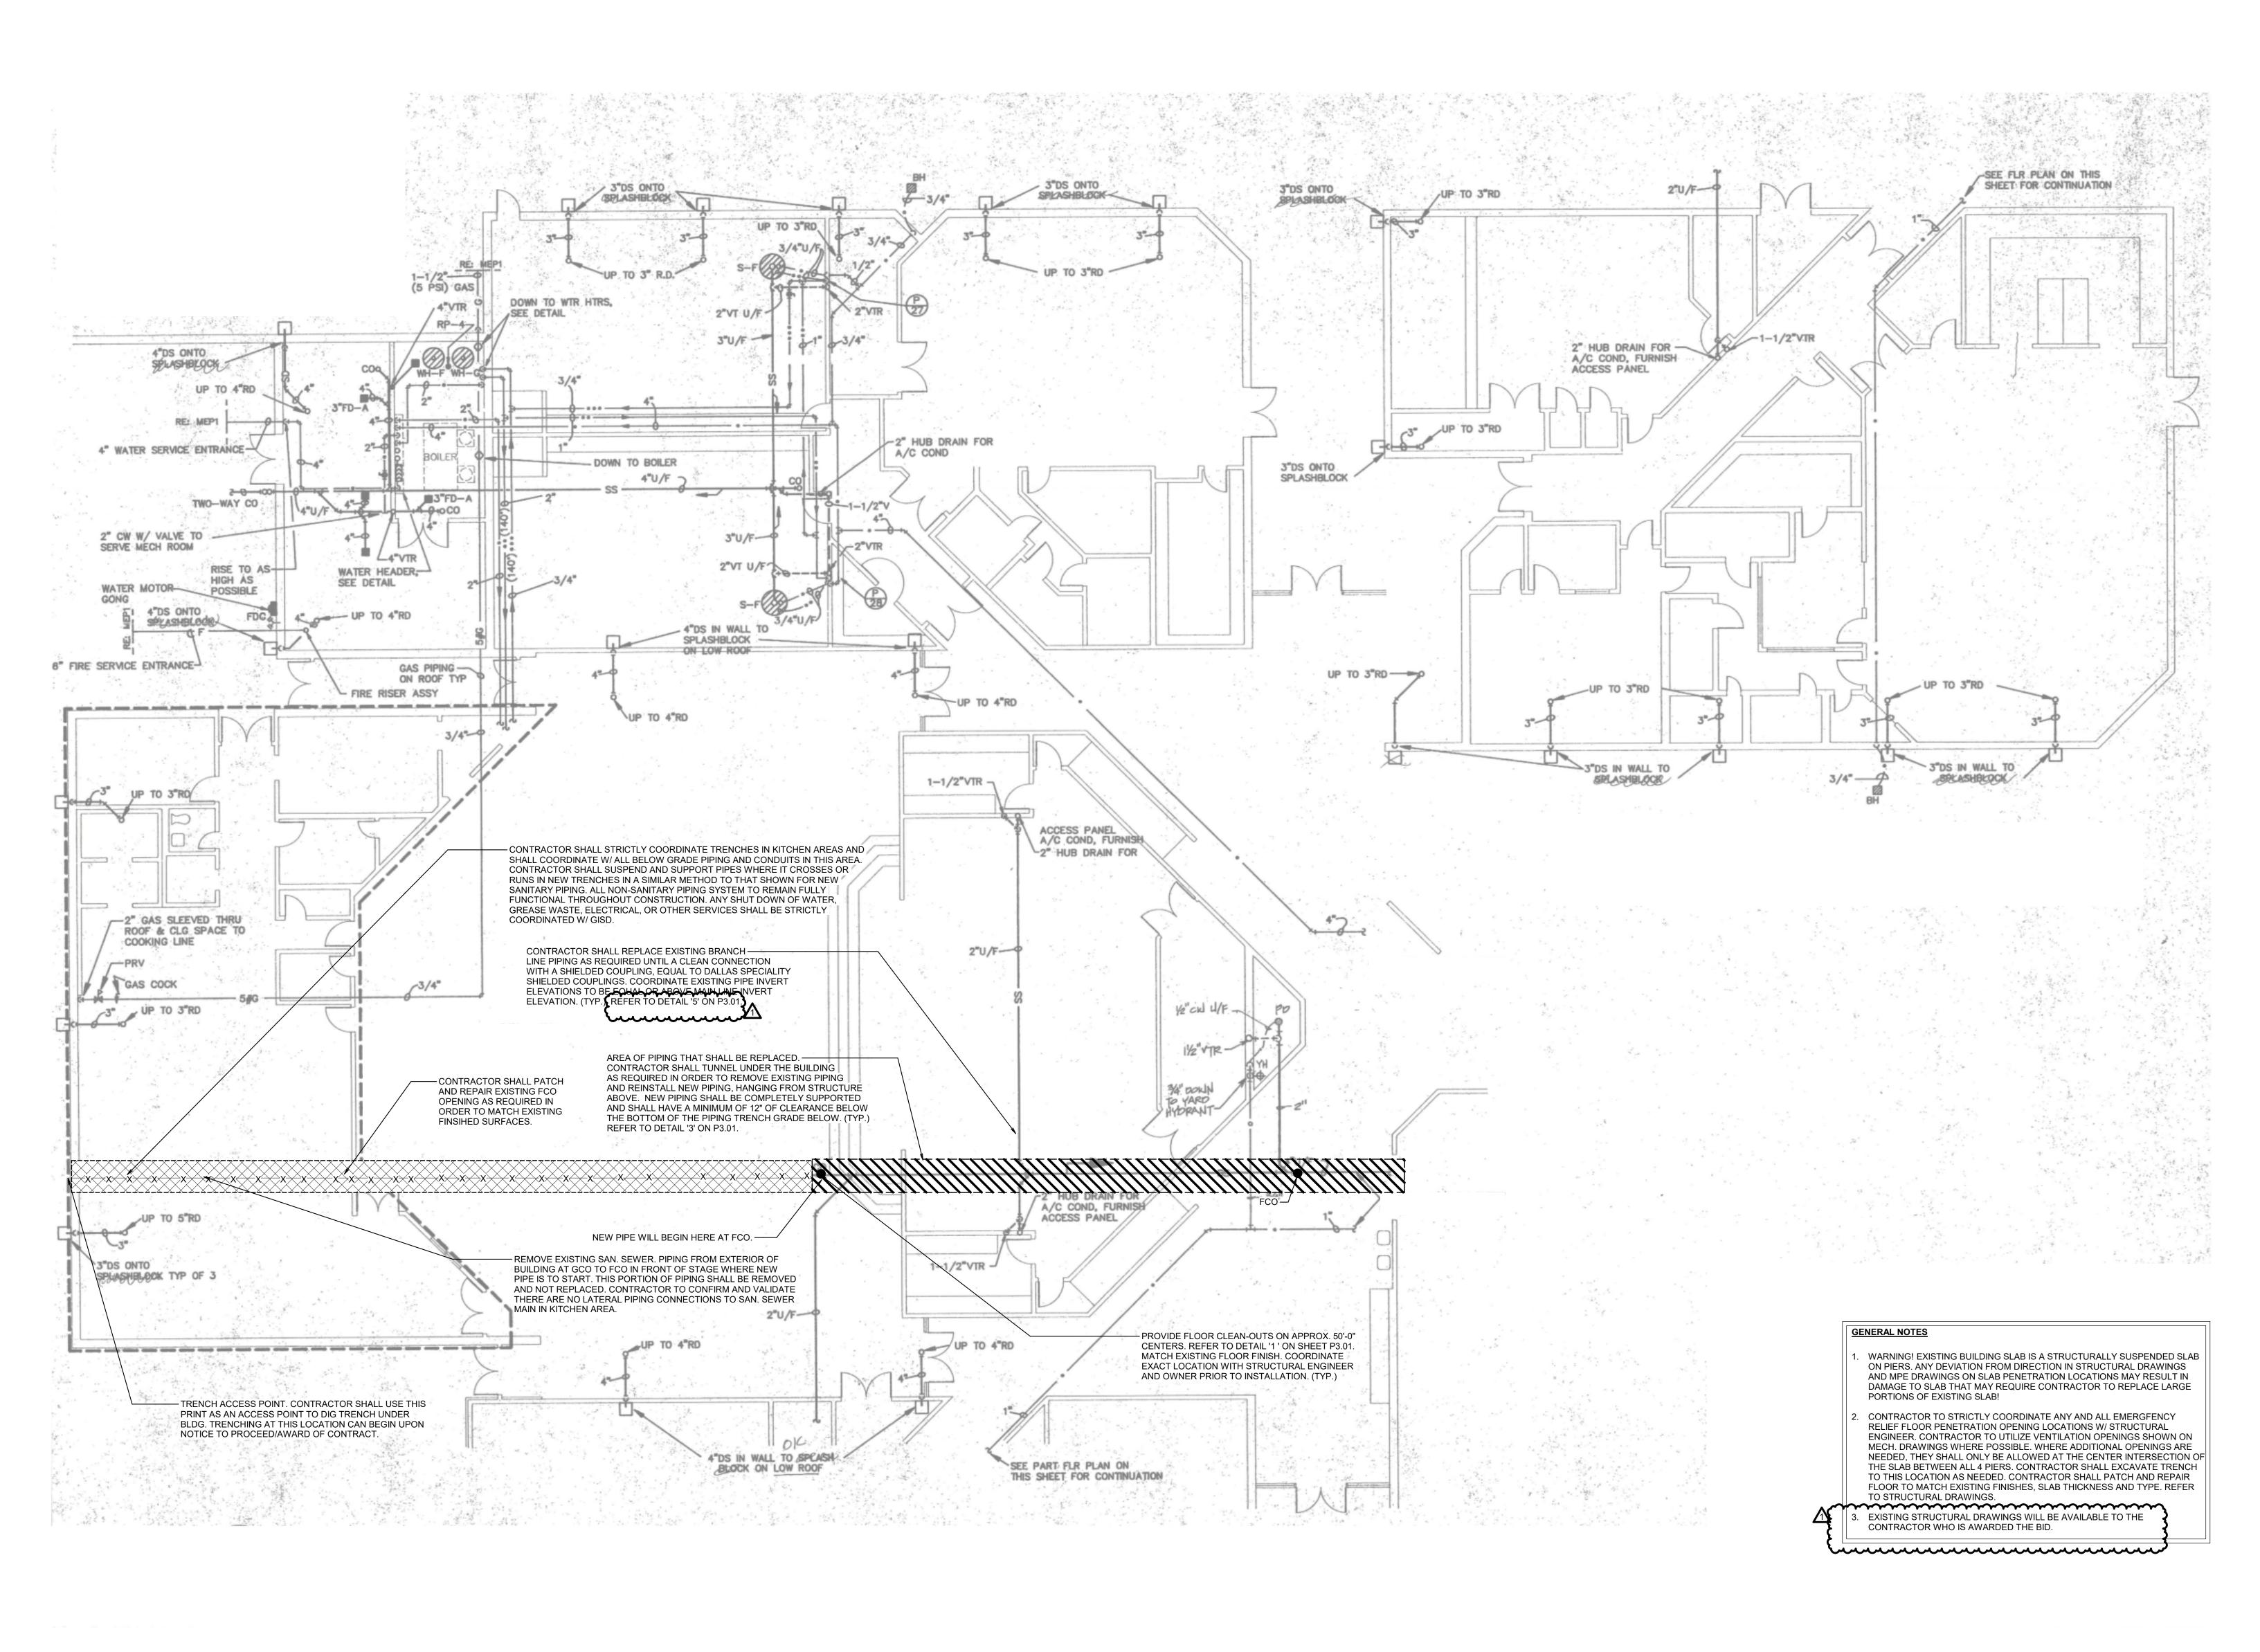

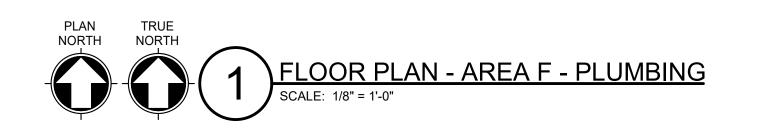

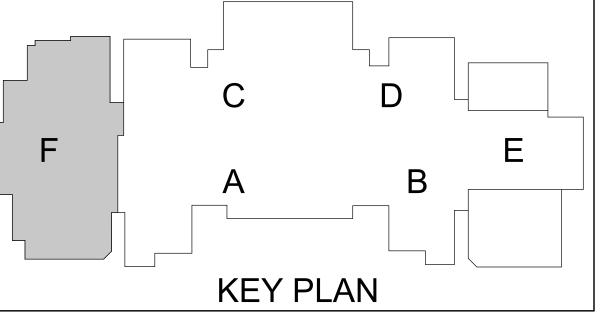





02.06.2023



EWER REVISIONS


EWER REVISIONS

FLOOR PLAN - AREA F - PLUMBING


JOB NO.: 22112.00 DRAWN BY: MD CHECKED BY: NH

P2.02




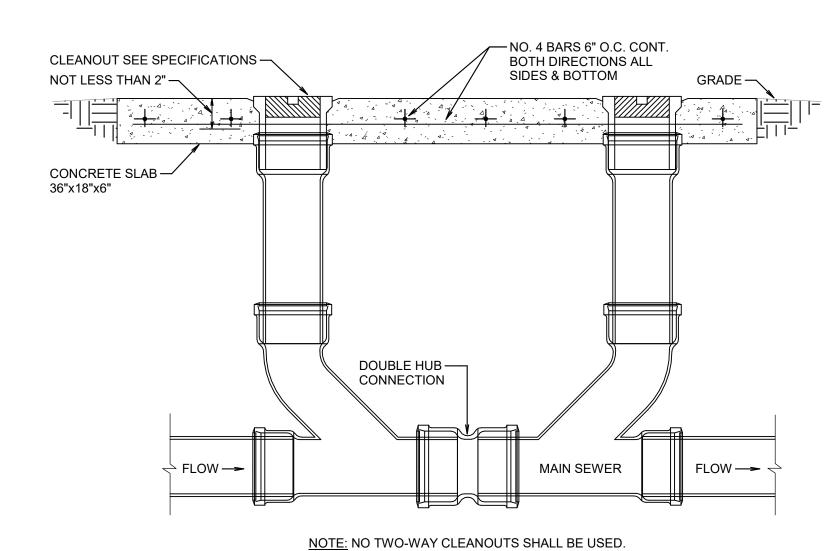



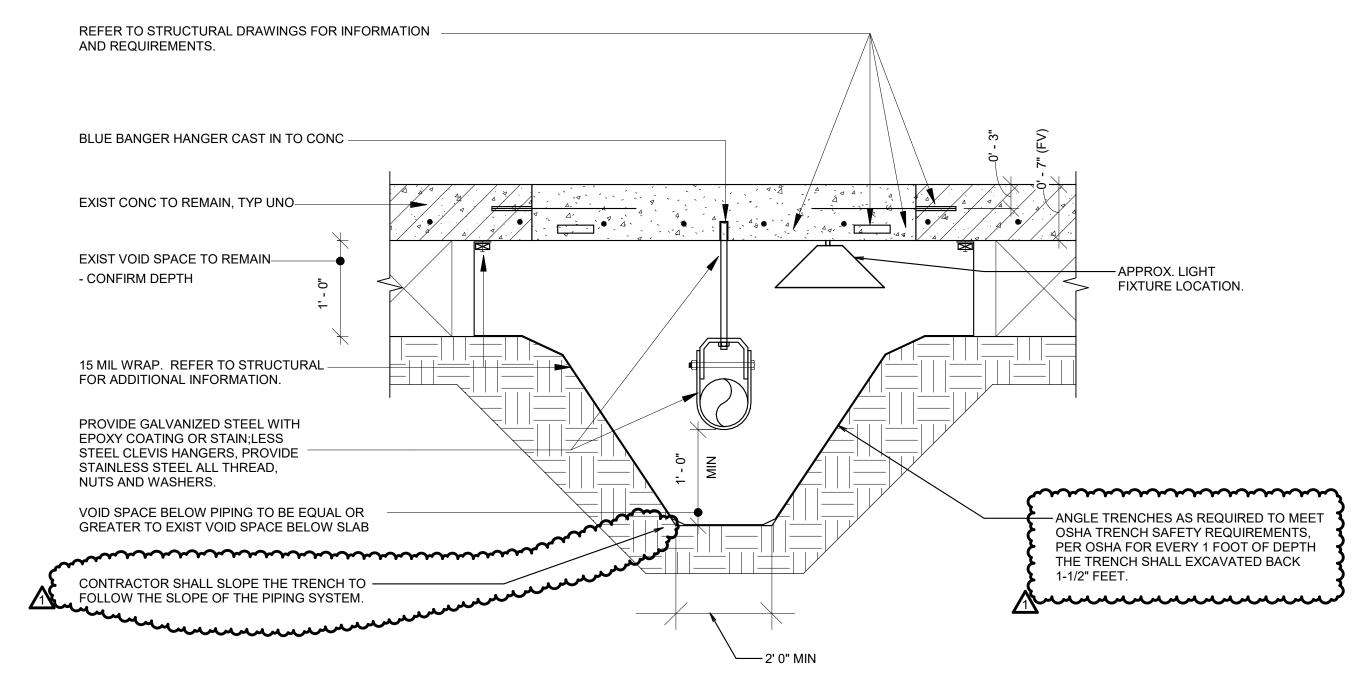


3 EXISTING FOUNDATION UNDERFLOOR PIPING/TRENCH DETAIL
NO SCALE

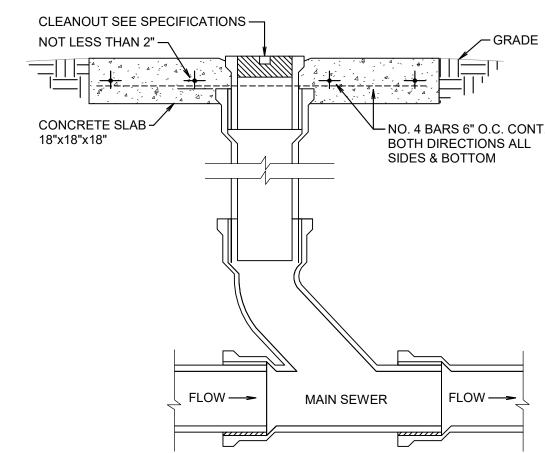

PLUMBING LEGEND					
SYMBOL DESCRIPTION					
	REPLACE/REWORK EXISTING PIPES				
_X_X_X_X_X_	EXISTING TO BE REMOVED				
CO	CLEAN OUT				
FCO	FLOOR CLEAN OUT				
GCO	GRADE CLEAN OUT				
DCO	DOUBLE CLEAN OUT				
ss	SANITARY WASTE (SS)				
NOTE: NOT ALL SYMBOLS SHOWN ARE NECESSARILY USED					



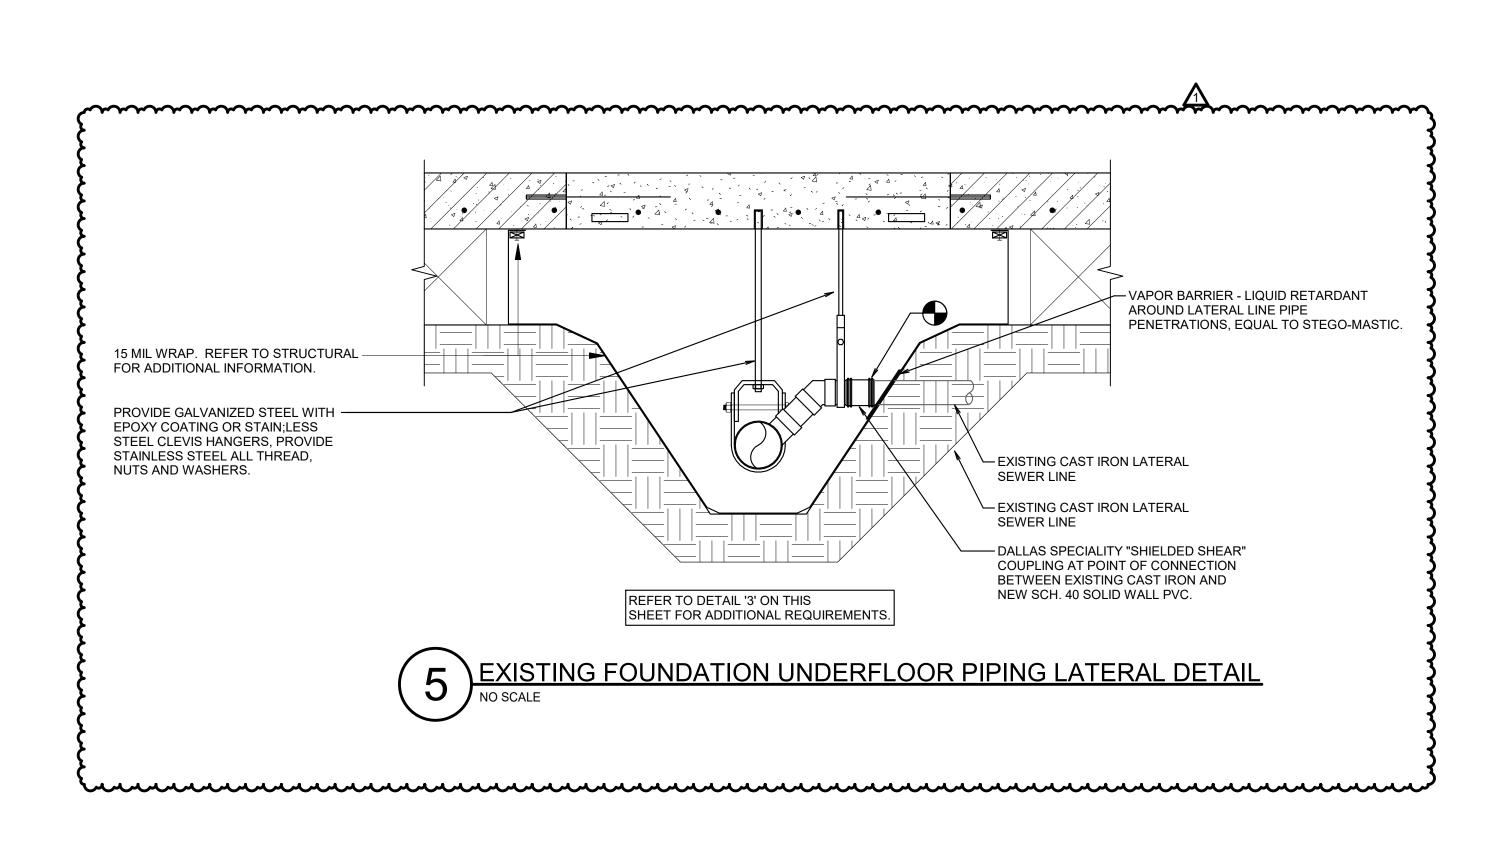

## **GENERAL CRAWLSPACE NOTE:**

- SUSPEND ALL CONDUIT AND SANITARY SEWER PIPING AS HIGH AS POSSIBLE IN CRAWLSPACE.
- 2. MAINTAIN A MINIMUM SLOPE ON ALL DRAIN LINES OF 1/8" PER FOOT, UNLESS NOTED OTHERWISE.
- 3. FOR DRAIN PIPING LOCATED IN CRAWL SPACES, SUSPEND PIPING AS HIGH AS POSSIBLE AND DO NOT DROP PIPING DOWN INTO THE GROUND AT THE FRONT OF THE BLDG UNTIL ABSOLUTELY REQUIRED TO MEET MINIMUM SLOPE REQUIREMENTS. OFFSET TO UNDERGROUND AT FRONT AS REQUIRED.
- 4. CONTRACTOR SHALL BACK FILL ALL TRENCH OPENINGS (ASSUMED TO BE THREE LOCATIONS) WITH NATIVE SOILS WHERE ALL PIPES OR TRENCH OPENINGS PASS UNDER EXTERIOR GRADE BEAMS. NATIVE SOIL BACK FILL SHALL EXTEND TO 2'-0" ON EITHER SIDE OF THE GRADE BEAM. REFER TO THE GEOTECHNICAL REPORT FOR THE DEFINITION AND REQUIREMENTS FOR NATIVE SOIL. SOIL FULLY COVER WIDTH AND HEIGHT OF OPENING UNDER

# GENERAL PLUMBING DEMOLITION NOTES:

1. THE INFORMATION SHOWN ON THE DEMOLITION DRAWINGS IS NOT TAKEN FROM "AS BUILT" DRAWINGS. CONTRACTOR SHALL BE RESPONSIBLE FOR VISITING THE SITE PRIOR TO SUBMITTING A BID TO DETERMINE THE GENERAL AMOUNT OF WORK THAT WILL BE REQUIRED. CONTRACTOR SHALL EXAMINE THE EXISTING BUILDING, VERIFY THE GENERAL LOCATION OF ALL EXISTING WORK, AND BECOME INFORMED AS TO THE RELATION TO AND IMPACT ON THE WORK REQUIRED. SUBMISSION OF A BID WILL CONSTITUTE EVIDENCE THAT THE CONTRACTOR HAS INSPECTED THE SITE IN THE FASHION NOTED ABOVE.

- 2. COORDINATE DEMOLITION WORK WITH BUILDING MAINTENANCE PERSONNEL AND OTHER TRADES PERFORMING WORK IN THE BUILDING PRIOR TO THE REMOVAL OF ANY ITEMS OF EQUIPMENT OR SYSTEMS THAT SHALL AFFECT OTHER SYSTEMS WITHING THE LIMITS OF NEW CONSTRUCTION OR OTHER AREAS OF THE EXISTING BUILDING.
- WORK SHOWN ON THE DEMOLITION DRAWINGS DOES NOT ACCURATELY REFLECT ALL OF THE EXISTING CONDITIONS OR THE COMPLETE SCOPE OF THE DEMOLITION WORK. THIS WORK SHALL BE BASED ON THE DEMOLITION DRAWINGS, EXISTING DRAWINGS MADE AVAILABLE TO THE CONTRACTOR AND
- 4. THE DRAWINGS ONLY REFLECT KNOWN AREAS OF DEMOLITION. CONTRACTOR SHALL BE RESPONSIBLE FOR FIELD VERIFICATION OF THE COMPLETE SCOPE OF THE DEMOLTITION WORK.
- 5. CONTRACTOR SHALL TRACE ALL PIPING BACK TO MAIN RISERS AND/OR SUPPLIES, AND VERIFY THAT PIPING DOES NOT SERVE ANY OTHER FIXTURES TO REMAIN. CONTRACTOR SHALL OBTAIN APPROVAL FROM OWNER'S REPRESENTATIVE PRIOR TO REMOVAL OF PIPING TO BE DEMOLISHED.
- 6. FLUSH AND CLEAN ALL EXISTING FLOOR DRAIN AND RELATED DRAIN PIPING AS NEEDED DURING CONSTRUCTION, AND AT THE COMPLETION OF THE PROJECT, TO PREVENT BLOCKAGE OF THE DRAINS WITH CONSTRUCTION DIRT, TRASH AND
- 7. CONTRACTOR SHALL PATCH AND REPAIR ALL WALLS, FLOORS AND CEILINGS TO MATCH EXISTING FINISHES OR PROPOSED NEW FINISHES, AS APPLICABLE, AND AS NECESSARY WHICH ARE AFFECTED BY THE REMOVAL AND/OR REWORK OF PLUMBING FIXTURES AND PIPING.

# GENERAL PLUMBING NOTES: VIDEO SCOPING: 1. AT THE COMPLETION OF CONSTRUCTION, THE CONTRACTOR SHALL VIDEO SCOPE

- THE SANITARY SEWER MAINS AND PROVIDE COPIES OF VIDEO SCOPE TO THE OWNER AND ENGINEER.
- 2. REPORTS SHALL BE WITH THE O&M MANUALS AS PART OF THE FINAL CLOSE OUT DOCUMENTS.

# **GENERAL PLUMBING NOTES:**

- 1. ALL DIMENSIONS AND FIELD CONDITIONS SHALL BE CHECKED AND VERIFIED BY CONTRACTOR AT THE SITE. THE LOCATION OF ALL NEW PIPING, FIXTURES, EQUIPMENT, LOCATIONS, SIZES, SCALES, AND DIMENSIONS SHALL BE CHECKED AND VERIFIED ON SITE.
- 2. CONTRACTOR SHALL LAY OUT THEIR WORK BASED ON ACTUAL FIELD MEASUREMENTS AND ACTUAL DIMENSIONS OF EQUIPMENT AND FIXTURS INSTALLED. ALL PIPING AND EQUIPMENT OF ALL TRADES SHALL BE PROPERLY COORDINATED AND SET IN PLACE TO MAINTAIN REQUIRED SERVICE CLEARANCES. ALL INSTALLATIONS SHALL BE SUBJECT TO THE APPROVAL OF THE ARCHITECT.
- 3. CONTRACTOR SHALL CHANGE THE LOCATION OF NEW PIPING, WHERE REQUIRED, TO MEET FIELD CONDITIONS.
- 4. CONTRACTOR SHALL SUBMIT COMPLETE PRODUCT DATA ALONG WITH SHOP DRAWINGS. PREPARE AND SUBMIT 1/4" = 1'-0" SCALE PLUMBING PIPING SHOP DRAWINGS. CONTRACTOR SHALL FULLY COORDINATE ALL PIPING SHOP DRAWINGS WITH SHEET METAL SHOP DRAWINGS AND WITH THE WORK OF ALL OTHER TRADES. PRIOR TO SUBMITTAL SHOP DRAWINGS SHALL BE CHECKED FOR OBSTRUCTIONS AND INTERFERENCES, ETC. FAILURE TO SUBMIT SHOP DRAWINGS IN A TIMELY MANNER AS REQUIRED TO KEEP PACE WITH THE CONSTRUCTION SCHEDULE MAY RESULT IN DELAYS, AND POSSIBLE STOPPAGE OF PAYMENT TO THE CONTRACTOR. ADDITIONALLY, NO WORK MAY PROCEED UNTIL SUCH SHOP DRAWINGS ARE SUBMITTED, REVIEWED, AND FOUND TO BE ACCEPTABLE BY THE ENGINEER.
- 5. REFER TO STRUCTURAL ENGINEER'S PLANS FOR ANTICIPATED EXISTING LOCATION OF STRUCTURAL PEIRS, BEAMS, JOISTS AND OTHER STRUCTURAL ELEMENTS. MODIFY PIPE ROUTING AS REQUIRED TO AVOID CONFLICTS WHERE SUCH OCCURS.
- 6. CONTRACTOR TO VALIDATE THE LOCATIONS OF ALL WALLS, PARTITIONS, CEILINGS, CEILING HEIGHTS, AND EQUIPMENT/FIXTURES IN BLDG IN SCOPE OF WORK AREA.
- 7. VERIFY EXACT FLOW LINE ELEVATIONS OF EXISTING WASTE MAINS PRIOR TO MAKING ANY CONNECTIONS OR ROUTING NEW EXTERIOR PIPING.
- 8. CONTRACTOR SHALL CONFIRM SCALE OF PLUMBING DRAWING TO VERIFY THE ACCURACY OF ALL TAKE-OFFS MADE DURING THE BIDDING PERIOD.

SERVICED FROM THE ACCESS LOCATION THE PANEL SHALL BE A MINIMUM OF 24"x24".

BELOW THESE BEAMS.

c. REPAIR LEAKS DISCOVERED DURING TEST.

- 9. ANY PIPE PENETRATIONS OF CEILINGS, WALLS OR FLOORS SHALL BE RESTORED TO THE EXISTING FIRE RATINGS. FLOOR, WALL AND CEILING PIPING PENETRATIONS SHALL BE PATCHED, SLEEVED, SEALED, AND BE PROVIDED WITH APPROPRIATE ESCUTCHEONS WHERE LOCATED IN FINISHED/EXPOSED SPACES.
- 10. CLEAN-OUTS LOCATED BEHIND ACCESS PANELS SHALL BE CENTERED ON THE ACCESS DOOR AND SHALL BE IMMEDIATELY ACCESSIBLE FROM THE ACCESS DOOR.
- 11. ACCESS DOORS OR ACCESS PANELS SHALL BE A MINIMUM OF 18"x18". WHERE MORE THAN ONE DEVICE IS
- 12. CONTRACTOR SHALL RUN ALL PLUMBING LINES AS HIGH AS POSSIBLE EXCEPT WHERE DIRECTED
- 13. SUSPEND SANITARY SEWER, STORM DRAIN & DOMESTIC WATER PIPING AS HIGH AS POSSIBLE. MAINTAIN A MINIMUM SLOPE ON ALL DRAIN LINES OF 1/8" PER FOOT. FOR DRAIN PIPING LOCATED IN CRAWL SPACES, SUSPEND PIPING AS HIGH AS POSSIBLE AND DO NOT DROP PIPING DOWN INTO SOIL UNTIL PERIMETER OF BLDG. UNDER THESE CONDITIONS OFFSET PIPE AT A 45 DEGREE ANGLE TO DROP THE PIPE TO BELOW GRADE AND TO CLEAR THE PERIMETER GRADE BEAM AND THE HEIGHT OF ANY CARTON FORMS LOCATED
- 14. CONTRACTOR SHALL NOT DEVIATE FROM THE CONSTRUCTION DOCUMENTS. ANY DEVIATION SHALL RECEIVE WRITTEN ACCEPTANCE AND APPROVAL FROM THE OWNER AND ENGINEER IN ADVANCE OF SUCH WORK BEING PERFORMED. SUBMIT SUCH REQUESTS TO TH ENGINEER ALONG WITH THE APPROPRIATE MONETARY CREDIT, AS APPLICABLE. ANY DEVIATIONS FROM THE CONTRACT DOCUMENTS FOUND ON THE PROJECT THAT DID NOT RECEIVE A LETTER OF ACCEPTANCE AND APPROVAL FROM THE OWNER OR ENGINEER SHALL BE FULLY REPLACED AND SHALL BE MADE TO BE IN FULL COMPLIANCE WITH THE CONTRUCTION DOCUMENTS AT THE EXPENSE OF THE CONTRACTOR.
- 15. CONTRACTOR SHALL PATCH AND REPAIR ALL WALLS, FLOORS AND CEILINGS AS NECESSARY THAT ARE AFFECTED BY THE CONNECTION TO EXISTING UTILITIES OR FOR TEMPORARY ACCESS HOLES IN THE EXISTING BUILDING FLOOR.
- 16. FINAL SMOKE TEST: AT THE COMPLETION OF PROJECT WHERE NEW SANITARY SEWER PIPING IS INSTALLED AND/OR EXISTING SANITARY SEWER PIPING IS MODIFIED, THE ENTIRE SANITARY SEWER SYSTEM FOR THE FACILITY SHALL BE TESTED AS INDICATED BELOW. GISD CONSTRUCTION MANAGER SHALL BE NOTIFIED (2) DAYS IN ADVANCE OF WHEN THE TEST SHALL OCCUR. CONTRACTOR SHALL DOCUMENT TESTING PROCEDURES, START TIME AND TIME OF COMPLETION. THIS INFORMATION SHALL BE INCLUDED INTO THE O&M MANUALS AS PART OF THE FINAL CLOSE OUT DOCUMENTS.


  a. PRODUCE SMOKE BY SMOKE MACHINE.
  b. MAINTAIN PRESSURE EQUAL TO 1 INCH WATER COLUMN FOR 15 MINUTES BEFORE INSPECTION STARTS.
- 17. CONTRACTOR TO PROVIDE VIDEO CAMERA RECORDING OF ALL EXISTING SANITARY SEWER LINES BELOW GRADE AT THE CONCLUSION OF PROJECT. GISD MANAGER SHALL BE NOTIFIED (2) DAYS IN ADVANCE OF THIS PROCEDURE. CONTRACTOR SHALL PROVIDE RESULTS OF VIDEO CAMERA RECORDINGS WITH THE O&M MANUALS AS PART OF THE FINAL CLOSE OUT DOCUMENTS.

d. REPEAT TEST UNTIL SYSTEM HOLD SMOKE FOR TEN (10) MINUTES WITHOUT SHOWING LEAKS.

Consulting Engineers

12001 N Central Expy
Suite 1100
Dallas, TX 75243

TX Firm #F-2176
(972) 788-4222
Project 22112.00

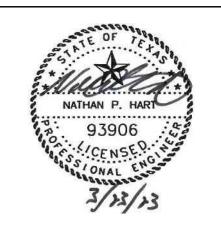

02.06.2023

	ISS	ISSUES				
	01	ISSUE FOR CONSTRUCTION	2023.02.0			
	RE	EVISIONS				
	01	ADDENDUM NO. 1	2023.03.2			
- 1	1	1				



# ARY SEWER REVISION

PLUMBING DETAILS & LEGEND

JOB NO.: 22112.00 DRAWN BY: MD CHECKED BY: NH

22 A1

SHEET NO.